

1 Overall Site Plan

C1 1"=80'




2 Locus

C1 1"=250'

3 Erosion Control Barrier - Silt Sock Detail

C1 Not to Scale

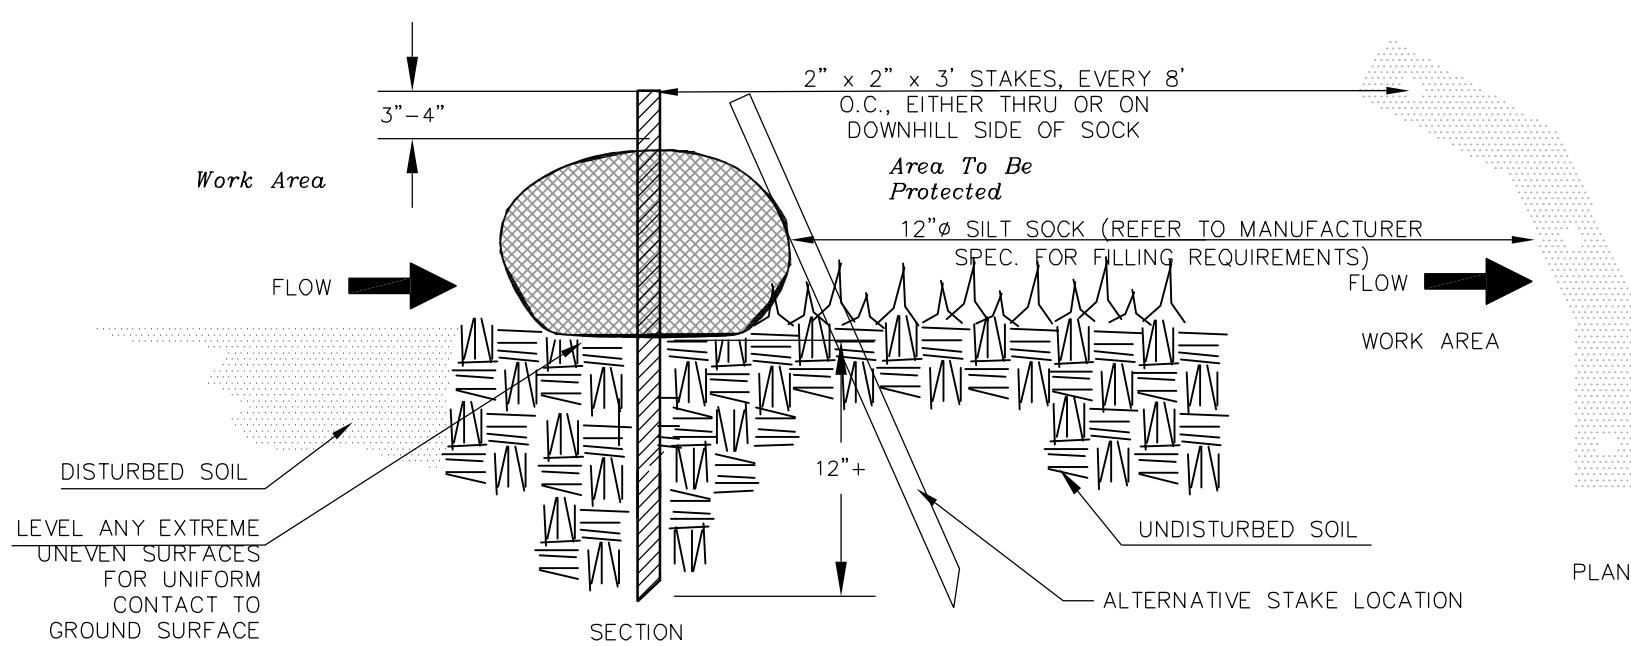


Erosion Control Notes

1. Prior to beginning construction, erosion control barriers shall be installed downgradient of fill slopes in any areas where ground is being disturbed, including but not limited to bridge footings and boardwalk supports..
2. Erosion control barriers shall consist of silt socks placed tightly end to end, as shown on the detail above. An additional stockpile of erosion control materials is to be stored on-site in an area that allows retrieving erosion control materials readily obtainable. The amount of stored erosion control materials is not to be less than 15% of materials used for the entire project. Stored materials are to be made up of similar materials used during initial production.

General Notes

1. Base plan prepared from GPS survey performed by Guntlow & Associates, Inc. in May 2021 and aerial GIS information. The Datum is NAD 83 and NAVD 1985.
2. Locations of underground utilities are shown in an approximate way, based only on available record data. Additional utilities may exist. Prior to construction, contractor shall call "Dig Safe" at 811 and have all utilities marked on the ground. The contractor shall be responsible for determining the exact location of all existing utilities before commencing work. The contractor agrees to be fully responsible for any and all damages which might be occasioned by his/her failure to exactly locate and preserve any and all utilities.
3. Care shall be taken not to damage any items designated to remain; repair or replacement of damaged items designated to remain shall be at the Contractors' expense.
4. The contractor shall coordinate all construction activities with the engineer, owner and town as applicable.
5. Erosion control measures shall conform to the details and notes relating to erosion control.
6. Contractor to maintain normal work hours between 7am and 5pm or as set forth by the Town of Shelburne.

Site Improvements Plan		REVISIONS		
DRAWN BY:	AIC	DATE:	6.4.2021	
CHECKED BY:	CJL	DRAWING NO.:		
JOB NO.:		SCALE:	1"=80'	
#		DESCRIPTION	DATE	WHOM

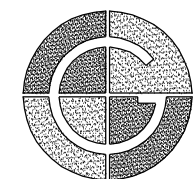

GUNTLOW & ASSOCIATES, INC.
ENGINEERS • SURVEYORS • ARCHITECTS
55 NORTH STREET
WILLIAMSTOWN, MA 01267
413-458-2108
413-458-2712 FAX

Shelburne Falls Riverside Trail
PREPARED FOR
Shelburne Open Space Committee
Deerfield Ave Shelburne Falls, MA

C1